NORTH BEARDSLEE LAKE MARSH RESTORATION PROJECT CONSTRUCTION DOCUMENTS JACKSON COUNTY, MS

PREPARED FOR:



MISSISSIPPI DEPARTMENT OF ENVIRONMENTAL QUALITY
515 E. AMITE STREET
JACKSON, MISSISSIPPI 39201

MARCH 2022

PREPARED BY:




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JACKSON / HATTIESBURG / MERIDIAN / PASCAGOULA /
ATLANTA / HOUSTON / DALLAS / BATON ROUGE / MOBILE

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GENERAL NOTES

- 1. THE CONTRACTOR SHALL BE RESPONSIBLE THAT HIS EMPLOYEES STRICTLY OBSERVE THE LAWS OF THE UNITED STATES OR OTHER GOVERNING BODY AFFECTING ALL OPERATIONS AT ALL SITES. THE CONTRACTOR SHALL COMPLY WITH ALL APPLICABLE LAWS UNDER WHICH HE IS OPERATING INCLUDING THOSE CONCERNING THE INSPECTION AND OPERATION OF EQUIPMENT AND THE LICENSING OF ENGINEERS, LAND SURVEYORS, PILOTS, MECHANICS AND OTHER PERSONNEL. IT IS FURTHER UNDERSTOOD AND AGREED THAT THE CONTRACTOR ASSUMES FULL RESPONSIBILITY FOR THE SAFETY OF HIS EMPLOYEES, EQUIPMENT, AND MATERIALS.
- 2. UTILITY LINES OR SERVICE LINES ENCOUNTERED DURING CONSTRUCTION, WHETHER SHOWN ON THE DRAWINGS OR NOT, SHALL BE PROTECTED BY THE CONTRACTOR AND REPAIRS NECESSARY DUE TO DAMAGE TO SAME BY THE CONTRACTOR SHALL BE AT NO ADDITIONAL COST TO OWNER. ANY UTILITY OR SERVICE LINES NOT SHOWN ON THE DRAWINGS SHALL BE REPORTED TO THE ENGINEER BEFORE CONTINUING WITH WORK AND SHALL BE INDICATED ON THE AS BUILT DRAWINGS. THE CONTRACTOR IS RESPONSIBLE FOR CONTACTING AND EXECUTION OF THE MISSISSIPPI ONE-CALL SYSTEM PURSUANT TO THE MISSISSIPPI CODE OF 1972 TITLE 77 CHAPTER 13 BEFORE AND THROUGHOUT THE WORK.
- 3. IF EVIDENCE OF THE PRESENCE OF ENDANGERED/THREATENED SPECIES IS FOUND DURING CONSTRUCTION, GROUND DISTURBING ACTIVITIES IN THE IMMEDIATE VICINITY OF THE PROJECT MUST CEASE, AND THE CONTRACTOR SHALL NOTIFY THE ENGINEER IMMEDIATELY.
- 4. CONSTRUCTION STAKING WILL BE BY THE CONTRACTOR AND SHALL BE AN ABSORBED COST ITEM.
- 5. THE CONTRACTOR SHALL BE RESPONSIBLE FOR COMPLETING ALL SAMPLING AND TESTING OF MATERIALS INCORPORATED INTO THE PROJECT AND FOR SUBMISSION OF SAME TO THE ENGINEER FOR REVIEW. ALL TESTING SHALL BE AN ABSORBED COST ITEM. PRIOR-USE TEST RESULTS, MANUFACTURER'S CERTIFICATES OR DATA SHEETS, AND PROPOSED MIX DESIGNS SHALL BE SUBMITTED TO THE ENGINEER FOR REVIEW AND APPROVAL BEFORE INCORPORATION INTO THE PROJECT. THIS SHALL INCLUDE FILL, ASPHALT, CONCRETE, FENCING, AGGREGATES, PAINT, SEALANTS, SEED, PIPE, GRATES, COVERS AND OTHER ITEMS AS SPECIFIED BY THE ENGINEER.
- 6. AT THE CONCLUSION OF THE BORROW EXCAVATION, CONTRACTOR SHALL GRADE ALL DISTURBED AREAS TO DRAIN.
- 7. OPERATIONS PERFORMED BY THE CONTRACTOR SHALL NOT INTERFERE WITH THE SAFE AND EFFICIENT OPERATION OF THE PASCAGOULA RIVER AND ADJACENT CHANNELS. IN THE EVENT OF AN EMERGENCY SITUATION, CONTRACTOR SHALL HALT WORK, OR PORTIONS THEREOF, AS DEEMED NECESSARY BY THE OWNER. NO ADDITIONAL COMPENSATION SHALL BE MADE FOR THE TEMPORARY BREAK IN WORK.
- 8. THE CONTRACTOR SHALL NOTE THAT PLAN SCALES WITHIN THIS PLAN ASSEMBLY VARY.
- 9. AT THE CLOSE OF EACH WORK DAY THE CONTRACTOR SHALL REMOVE ALL DEBRIS, LOOSE MATERIALS, OR OTHER WASTE FROM THE WORK SITE, AND LEAVE THE WORK SITE IN A CLEAN AND SAFE CONDITION.
- 10. THE CONTRACTOR SHALL SUBMIT A WORK PLAN AS A PART OF THEIR BID PACKAGE BASED ON THE INFORMATION IN THE CONTRACT DOCUMENTS TO INDICATE THE ORIGINAL LOCATION OF THE MATERIAL, TRANSFER METHOD, PLACEMENT METHOD AND PLACEMENT SEQUENCE OF THE FILL MATERIAL. THE PLAN SHALL DESCRIBE ALL ASSUMPTIONS, STATEMENTS OF FACT, AND COMPUTATIONS, AND SHALL INCLUDE A NARRATIVE TO FULLY EXPLAIN THE PROCEDURES THE CONTRACTOR WILL FOLLOW DURING THE CONTRACT. IF REQUIRED, THE CONTRACTOR SHALL INCLUDE THE PIPELINE PLACEMENT ROUTING IN THE WORK PLAN.
- 11. CONTRACTOR SHOULD ASSURE AN UNDERSTANDING ON THE PART OF EMPLOYEE AND SUPERVISOR ALIKE THAT NO NEW TASK HAVING POTENTIAL AS A HAZARD WILL BE UNDERTAKEN WITHOUT THOROUGH DISCUSSION BETWEEN THEM TO DETERMINE THE SAFEST MEANS TO ACCOMPLISH THE TASK. THE JOB HAZARD ANALYSIS WILL THEN BE MODIFIED ACCORDINGLY.
- 12. IF ANY SHIPWRECK, ARTIFACT, OR OTHER OBJECTS OF ANTIQUITY THAT HAVE SCIENTIFIC OR HISTORICAL VALUE, OR ARE OF INTEREST TO THE PUBLIC, ARE DISCOVERED, LOCATED, AND/OR RECOVERED, THE CONTRACTOR ACKNOWLEDGES THAT:
- a. THE SITE(S), ARTICLES, OR OTHER MATERIALS ARE THE PROPERTY OF THE STATE OF MISSISSIPPI, WITH TITLE VESTED IN THE DEPARTMENT OF ARCHIVES AND HISTORY; AND THAT,
- b. HE SHALL IMMEDIATELY NOTIFY MDEQ. REFER TO SUBPARAGRAPH "PRESERVATION AND RECOVERY OF HISTORIC, ARCHEOLOGICAL, AND CULTURAL RESOURCES" OF SECTION 01 35 43 ENVIRONMENTAL PROTECTION.
- 13. FINAL CLEANUP SHALL INCLUDE THE REMOVAL OF ALL OF THE CONTRACTOR'S EQUIPMENT AND MATERIAL, EITHER FOR DISPOSAL OR REUSE. EQUIPMENT AND MATERIAL TO BE DISPOSED OF SHALL ONLY BE DISPOSED OF IN A MANNER AND AT LOCATIONS APPROVED BY MDEQ. UNLESS OTHERWISE APPROVED IN WRITING, THE CONTRACTOR WILL NOT BE PERMITTED TO ABANDON PONTOONS OR OTHER EQUIPMENT IN THE DISPOSAL AREA, WATER AREAS, OR OTHER AREAS ADJACENT TO THE WORK SITE. PILINGS AND ANY OTHER DEBRIS REMOVED OR CREATED AS A RESULT OF THE EXECUTION OF THIS CONTRACT SHALL BE DISPOSED OF IN A MANNER AND AT LOCATIONS APPROVED BY MDEQ.
- 14. STAGING AREAS: THE CONTRACTOR SHALL IDENTIFY STAGING AND ACCESS AREAS. STAGING AND ACCESS AREAS SHALL BE APPROVED BY MDEQ PRIOR TO COMMENCEMENT OF CONSTRUCTION. THE STAGING AREAS SHALL NOT BE USED FOR STOCKPILING OF NOURISHMENT FILL MATERIAL. THE FINAL LIMITS OF THE STAGING AND ACCESS AREAS SHALL BE FIELD-DETERMINED BY MDEQ IN COORDINATION WITH THE CONTRACTOR. IT SHALL BE THE RESPONSIBILITY OF THE CONTRACTOR TO INVESTIGATE AND OBTAIN ALL AREAS WHICH MAY BE NECESSARY FOR HIS/HER CONSTRUCTION OPERATIONS.
- 15. THE CONTRACTOR SHALL EXCLUDE THE PUBLIC FROM THE WORK AREA IN THE IMMEDIATE VICINITY OF HIS OPERATIONS. THE CONTRACTOR SHALL INSTALL WARNING SIGNS TO WARN THE PUBLIC AND ALL COMMERCIAL RECREATIONAL BOATS OF ALL CONSTRUCTION ACTIVITIES. THE CONTRACTOR SHALL MARK IN A CONSPICUOUS MANNER THE MOORING AND STAGING AREAS FOR ALL EQUIPMENT. THE CONTRACTOR SHALL BE RESPONSIBLE FOR PROVIDING AND MAINTAINING ALL WATER AND LAND ACCESS ROUTES NECESSARY FOR HIS EQUIPMENT TO AND FROM THE WORK SITES. THE CONTRACTOR SHALL ASCERTAIN THE ENVIRONMENTAL CONDITIONS WHICH CAN AFFECT WATER AND LAND ACCESS, SUCH AS CLIMATE, TERRAIN, WINDS, CURRENT, WAVES, SWELLS, DEPTHS, SHOALING, AND SCOURING TENDENCIES.
- 16. THE CONTRACTOR SHALL DISPLAY SIGNAL LIGHTS AND CONDUCT OPERATIONS IN ACCORDANCE WITH THE GENERAL REGULATIONS OF THE DEPARTMENT OF THE ARMY AND OF THE COAST GUARD GOVERNING LIGHTS AND DAY SIGNALS TO BE DISPLAYED BY TOWING VESSELS WITH TOWS ON WHICH NO SIGNALS CAN BE DISPLAYED, VESSELS WORKING ON WRECKS AND VESSELS ENGAGED IN THE WORK OR IN SUBMARINE OR BANK PROTECTION OPERATIONS, LIGHTS AND DAY SIGNALS TO BE DISPLAYED BY VESSELS OF MORE THAN 65 FEET IN LENGTH MOORED OR ANCHORED IN A FAIRWAY OR CHANNEL, AND THE PASSING BY OTHER VESSELS WORKING IN NAVIGABLE CHANNELS, AS SET FORTH IN COMMANDANT U.S. COAST GUARD INSTRUCTION M16672.2, NAVIGATION RULES: INTERNATIONAL-INLAND (COMDTINST M16672.2), OR 33 CFR 81 APPENDIX A (INTERNATIONAL) AND 33 CFR 84 THROUGH 33 CFR 89 (INLAND) AS APPLICABLE.
- 17. IT SHALL BE THE RESPONSIBILITY OF THE CONTRACTOR TO MAINTAIN AND PRESERVE THE PROPER PLACEMENT OF ALL EXISTING NAVIGATIONAL BUOYS.
- 18. THE CONTRACTOR, OR A REPRESENTATIVE WITH FULL AUTHORITY TO ACT FOR HIM IN ALL MATTERS PERTAINING TO THE ADMINISTRATION OF THE CONTRACT AND TO THE CARE AND OPERATION OF THE PROJECT EQUIPMENT, SHALL BE ON THE ACTUAL WORK SITE AT ALL TIMES WORK IS BEING PERFORMED. THE CONTRACTOR SHALL SUBMIT THE NAMES OF HIS REPRESENTATIVES, INCLUDING RESUMES OF THEIR QUALIFICATIONS, TO MDEQ IN WRITING PRIOR TO THE COMMENCEMENT OF WORK. IT IS EXPRESSLY UNDERSTOOD THAT THE ACTIONS TAKEN BY THE NAMED REPRESENTATIVES WITH RESPECT TO THE ADMINISTRATION OF THE CONTRACT AND TO THE CARE AND OPERATION OF THE EQUIPMENT SHALL BE LEGALLY BINDING ON THE CONTRACTOR.
- 19. THE CONTRACTOR SHALL FURNISH AND MAINTAIN FOR ITS USE RADIOS FOR COMMUNICATION WITH THE MDEQ, THE US COAST GUARD, AND OTHER VESSELS. RADIO(S) MUST BE CERTIFIED AS BEING OPERABLE ON THE SPECIFIED FREQUENCIES. MARINE VHF RADIO, FCC TYPE ACCEPTED WITH THE FOLLOWING CHANNELS: CHANNEL 16, (156.8 MHZ), CHANNEL 13 (156.65 MHZ), CHANNEL 12, (156.6 MHZ, CHANNEL 14, (156.7 MHZ), AND CHANNELS 26 AND 28 FOR PUBLIC CORRESPONDENCE. A SEPARATE RECEIVER MUST BE PROVIDED ON CHANNEL 13, (156.6 MHZ) IN COMPLIANCE WITH PUBLIC LAW 92-63.
- 20. THE SITE OF WORK IS EXPOSED TO LOCAL DISTURBANCES IN BEARDSLEE LAKE AND UPPER GULF OF MEXICO WHICH MAY CAUSE SUSPENSION OF THE WORK FOR SHORT PERIODS OF TIME. GENERALLY, THIS SITE DOES NOT PROVIDE SAFE REFUGE FROM TROPICAL STORMS AND/OR HURRICANES WHICH MAY OCCUR FROM JUNE TO DECEMBER. SHOULD A HURRICANE OCCUR DURING THE COURSE OF THE WORK, IT WILL BE THE RESPONSIBILITY OF THE CONTRACTOR TO SELECT A SAFE HARBOR. THIS WORK AREA IS AFFECTED BY EXTENDED PERIODS OF STRONG WINDS, PREDOMINATELY FROM THE SOUTH OR SOUTHEAST.
- 21. THE TRAFFIC EXPECTED TO USE THE AREA DURING THE PROGRESS OF THE WORK WILL CONSIST OF PLEASURE CRAFT, FISHING VESSELS, AND TOWBOATS WITH BARGES. THE CONTRACTOR SHALL NOT IMPEDE COMMERCIAL VESSEL NAVIGATION WITHIN THE PASCAGOULA OR ESCATAWPA RIVERS.
- 22. THE CONTRACTOR WILL BE REQUIRED TO PREPARE AND MAINTAIN DAILY REPORTS OF OPERATIONS TO BE COMBINED WEEKLY. FURTHER INSTRUCTIONS ON THE PREPARATION OF THE REPORTS WILL BE FURNISHED AT THE PRE-CONSTRUCTION CONFERENCE.
- 23. THE CONTRACTOR SHALL MAINTAIN AN ACCURATE RECORD OF, AND SHALL REPORT TO MDEQ, ALL ACCIDENTS WITHIN 24 HOURS OF THE OCCURRENCE AND ALL SERIOUS ACCIDENTS (THOSE RESULTING IN DEATH OR INJURY REQUIRING MEDICAL ATTENTION) SHALL BE REPORTED IMMEDIATELY
- 24. CONTRACTOR IS RESPONSIBLE FOR SECURITY OF THE PROJECT SITE, MATERIAL STOCKPILES, PLANT, EQUIPMENT AND MATERIALS. THE CONTRACTOR SHALL AT ALL TIMES PROTECT AND PRESERVE ALL MATERIALS, SUPPLIES AND EQUIPMENT OF EVERY DESCRIPTION AND ALL WORK PERFORMED.
- 25. CONTRACTOR WILL BE RESPONSIBLE FOR A MINIMUM OF BI-WEEKLY INSPECTIONS OF THE EQUIPMENT DURING TIMES WHEN REGULAR WORK IS NOT BEING PERFORMED. INSPECTIONS REPORTS SHALL BE SUBMITTED TO THE MDEQ AFTER EACH INSPECTION STATING THE CONDITION OF THE EQUIPMENT AND ANY CORRECTIVE ACTION THAT WAS NECESSARY.
- 26. THE CONTRACTOR SHALL ENSURE THAT TURBIDITY OUTSIDE THE LIMITS OF 750-FOOT MIXING ZONE SHALL NOT EXCEED TURBIDITY BY MORE THAN 50 NEPHELOMETRIC TURBIDITY UNITS (NTUS). TURBIDITY CURTAIN MAY BE LEFT IN PLACE BETWEEN CONSTRUCTION PHASES PROVIDED IT REMAINS IN A CONDITION ACCEPTABLE TO PERFORM ITS INTENDED FUNCTIONS.
- 27. ANY CLEARING OR RUBBISH DISPOSAL REQUIRED TO OBTAIN FILL MATERIAL FROM DISPOSAL AREAS WILL BE AN ABSORBED COST TO THE CONTRACTOR.

SCALE: AS SHOWN

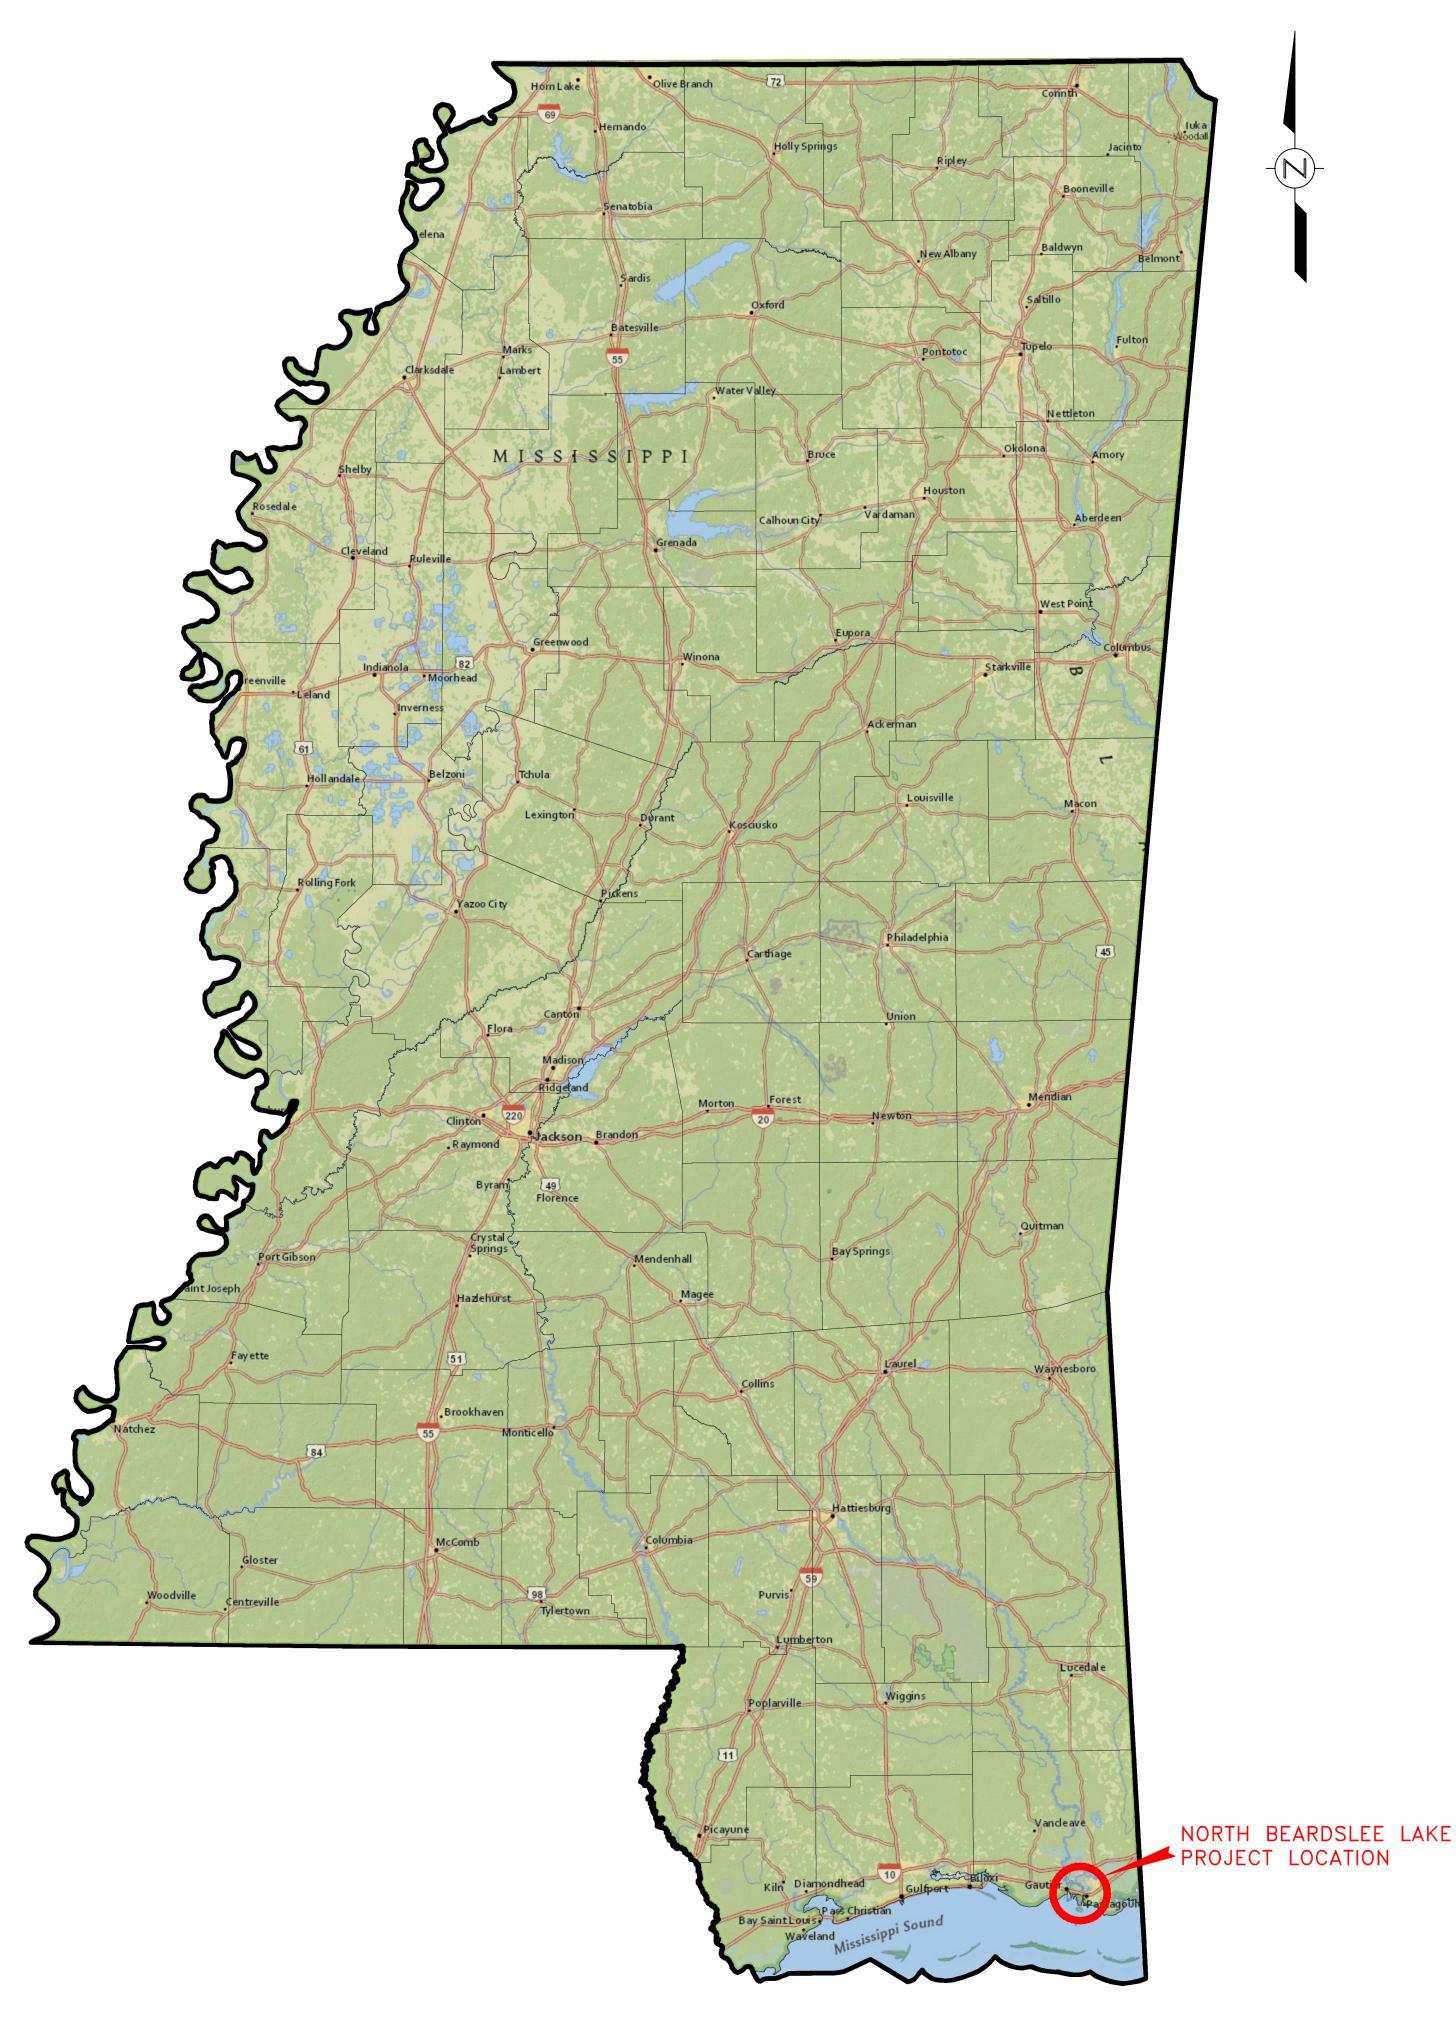DRAWN: P. LANNING

DATE: 11/02/2021

CHECKED: W. PENTECOST

REVIEWED: J. BOURGEOIS

PROJECT MANAGER: J. BOURGEOIS

- 28. CONTRACTOR SHALL PROVIDE TEMPORARY NAVIGATIONAL AIDS AS REQUIRED TO MARK ALL CONSTRUCTION EQUIPMENT, TURBIDITY CURTAIN, AND OTHER APPURTENANCES NECESSARY TO IDENTIFY THE OBSTRUCTION IN DAYLIGHT AND DARK CONDITIONS. TEMPORARY NAVIGATIONAL AIDS SHALL BE INCLUDED AS AN ABSORBED COST ITEM.
- 29. THE CONTRACTOR SHALL MAINTAIN AS-BUILT DRAWINGS AND PROVIDE SUCH DRAWINGS TO THE ENGINEER WITHIN THREE (3) WEEKS AFTER COMPLETION OF EACH PHASE OF THE PROJECT.

DRAWING INDEX				
DRAWING NO.	DESCRIPTION	REVISION NO.		
	TITLE PAGE	0		
CO.1	PROJECT LOCATION MAP, GENERAL NOTES AND DRAWING INDEX	0		
NB0.1	VICINITY MAP	0		
NB1.1	EXISTING CONDITIONS PLAN	0		
NB1.2	SITE PLAN	0		
NB1.3	PLANTING PLAN	0		
NB2.1	TYPICAL SECTIONS AND DETAILS	0		
NB3.1	PHASED DREDGE PLACEMENT PLAN	0		

PROJECT LOCATION MAP

SCALE: NOT TO SCALE

0	ISSUED FOR REVIEW	JCB	11/02/2021
REV.	DESCRIPTION OF REVISION	BY	CURRENT DATE



ENGINEERING AND SCIENCE


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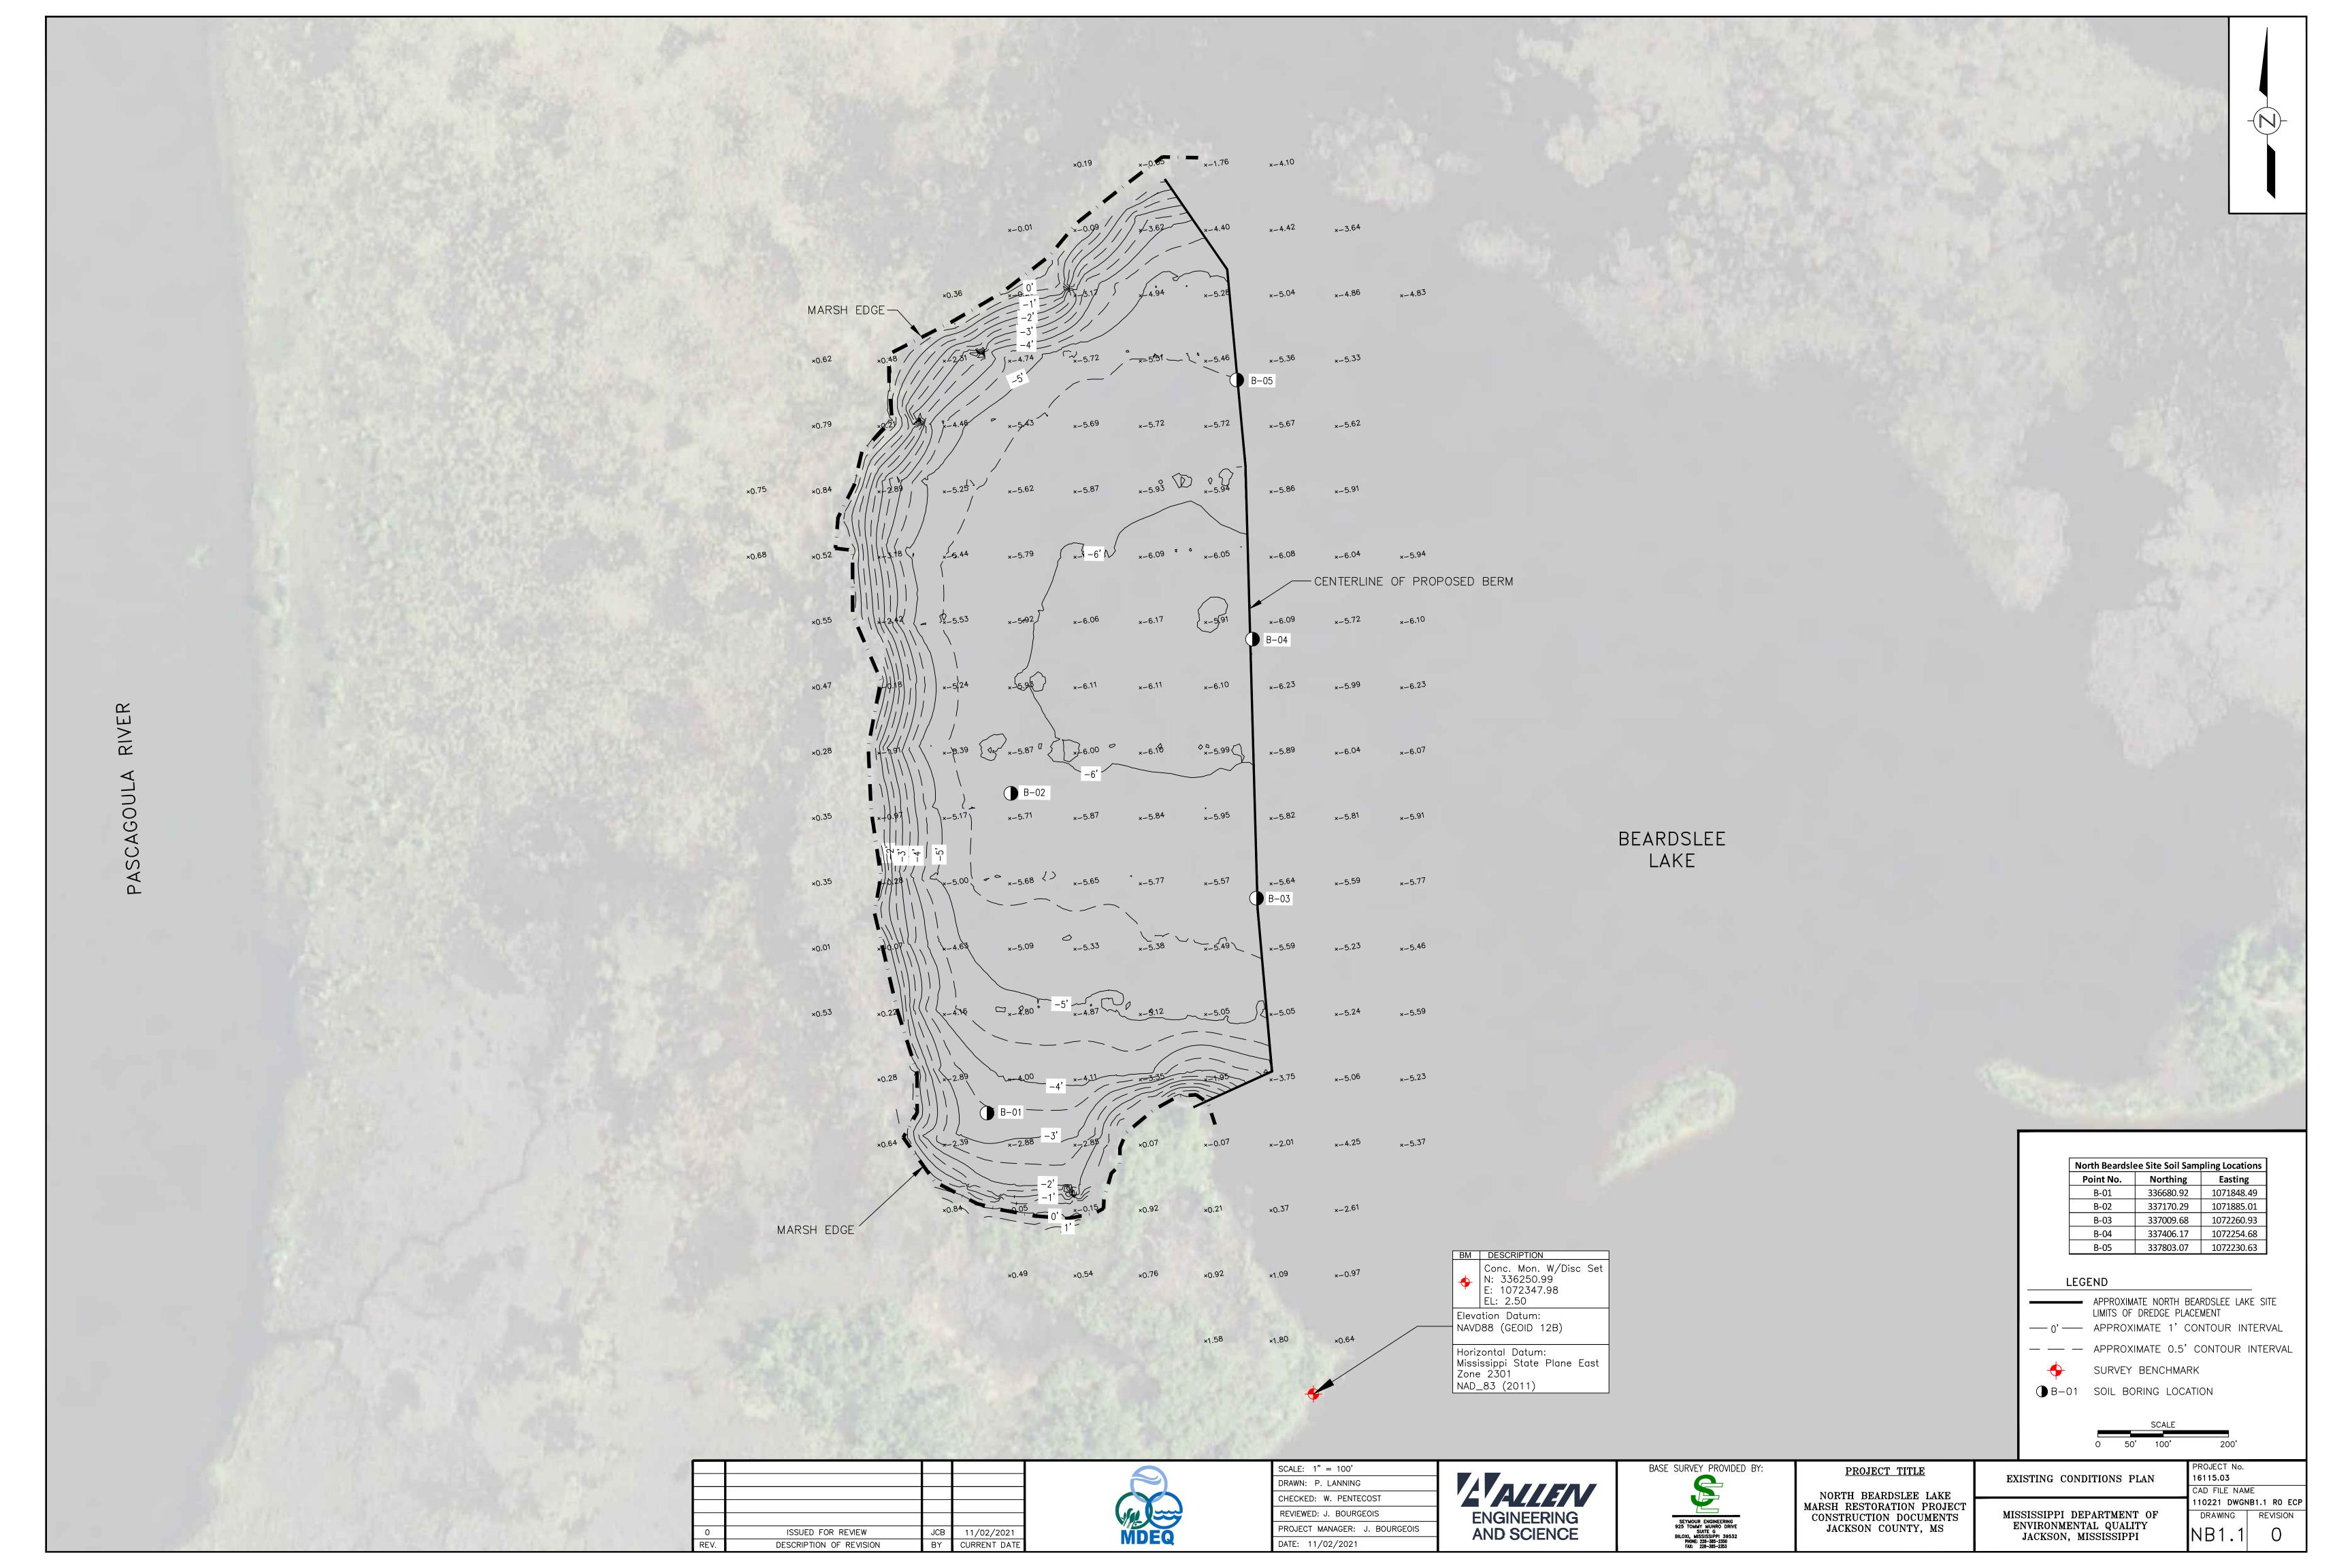
NORTH BEARDSLEE LAKE
MARSH RESTORATION PROJECT
CONSTRUCTION DOCUMENTS
JACKSON COUNTY, MS


PROJECT LOCATION MAP, GENERAL NOTES AND DRAWING INDEX


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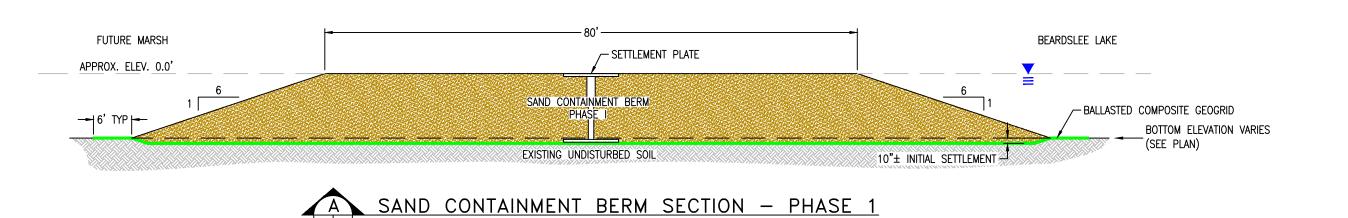
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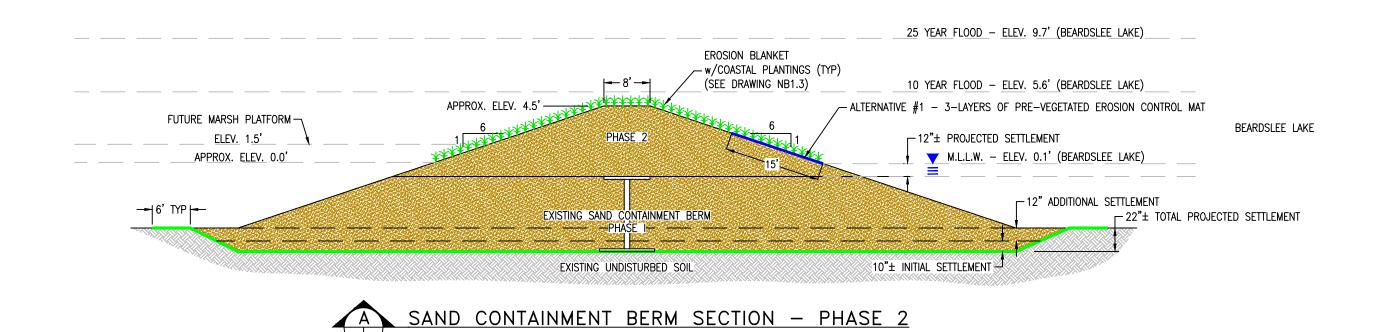




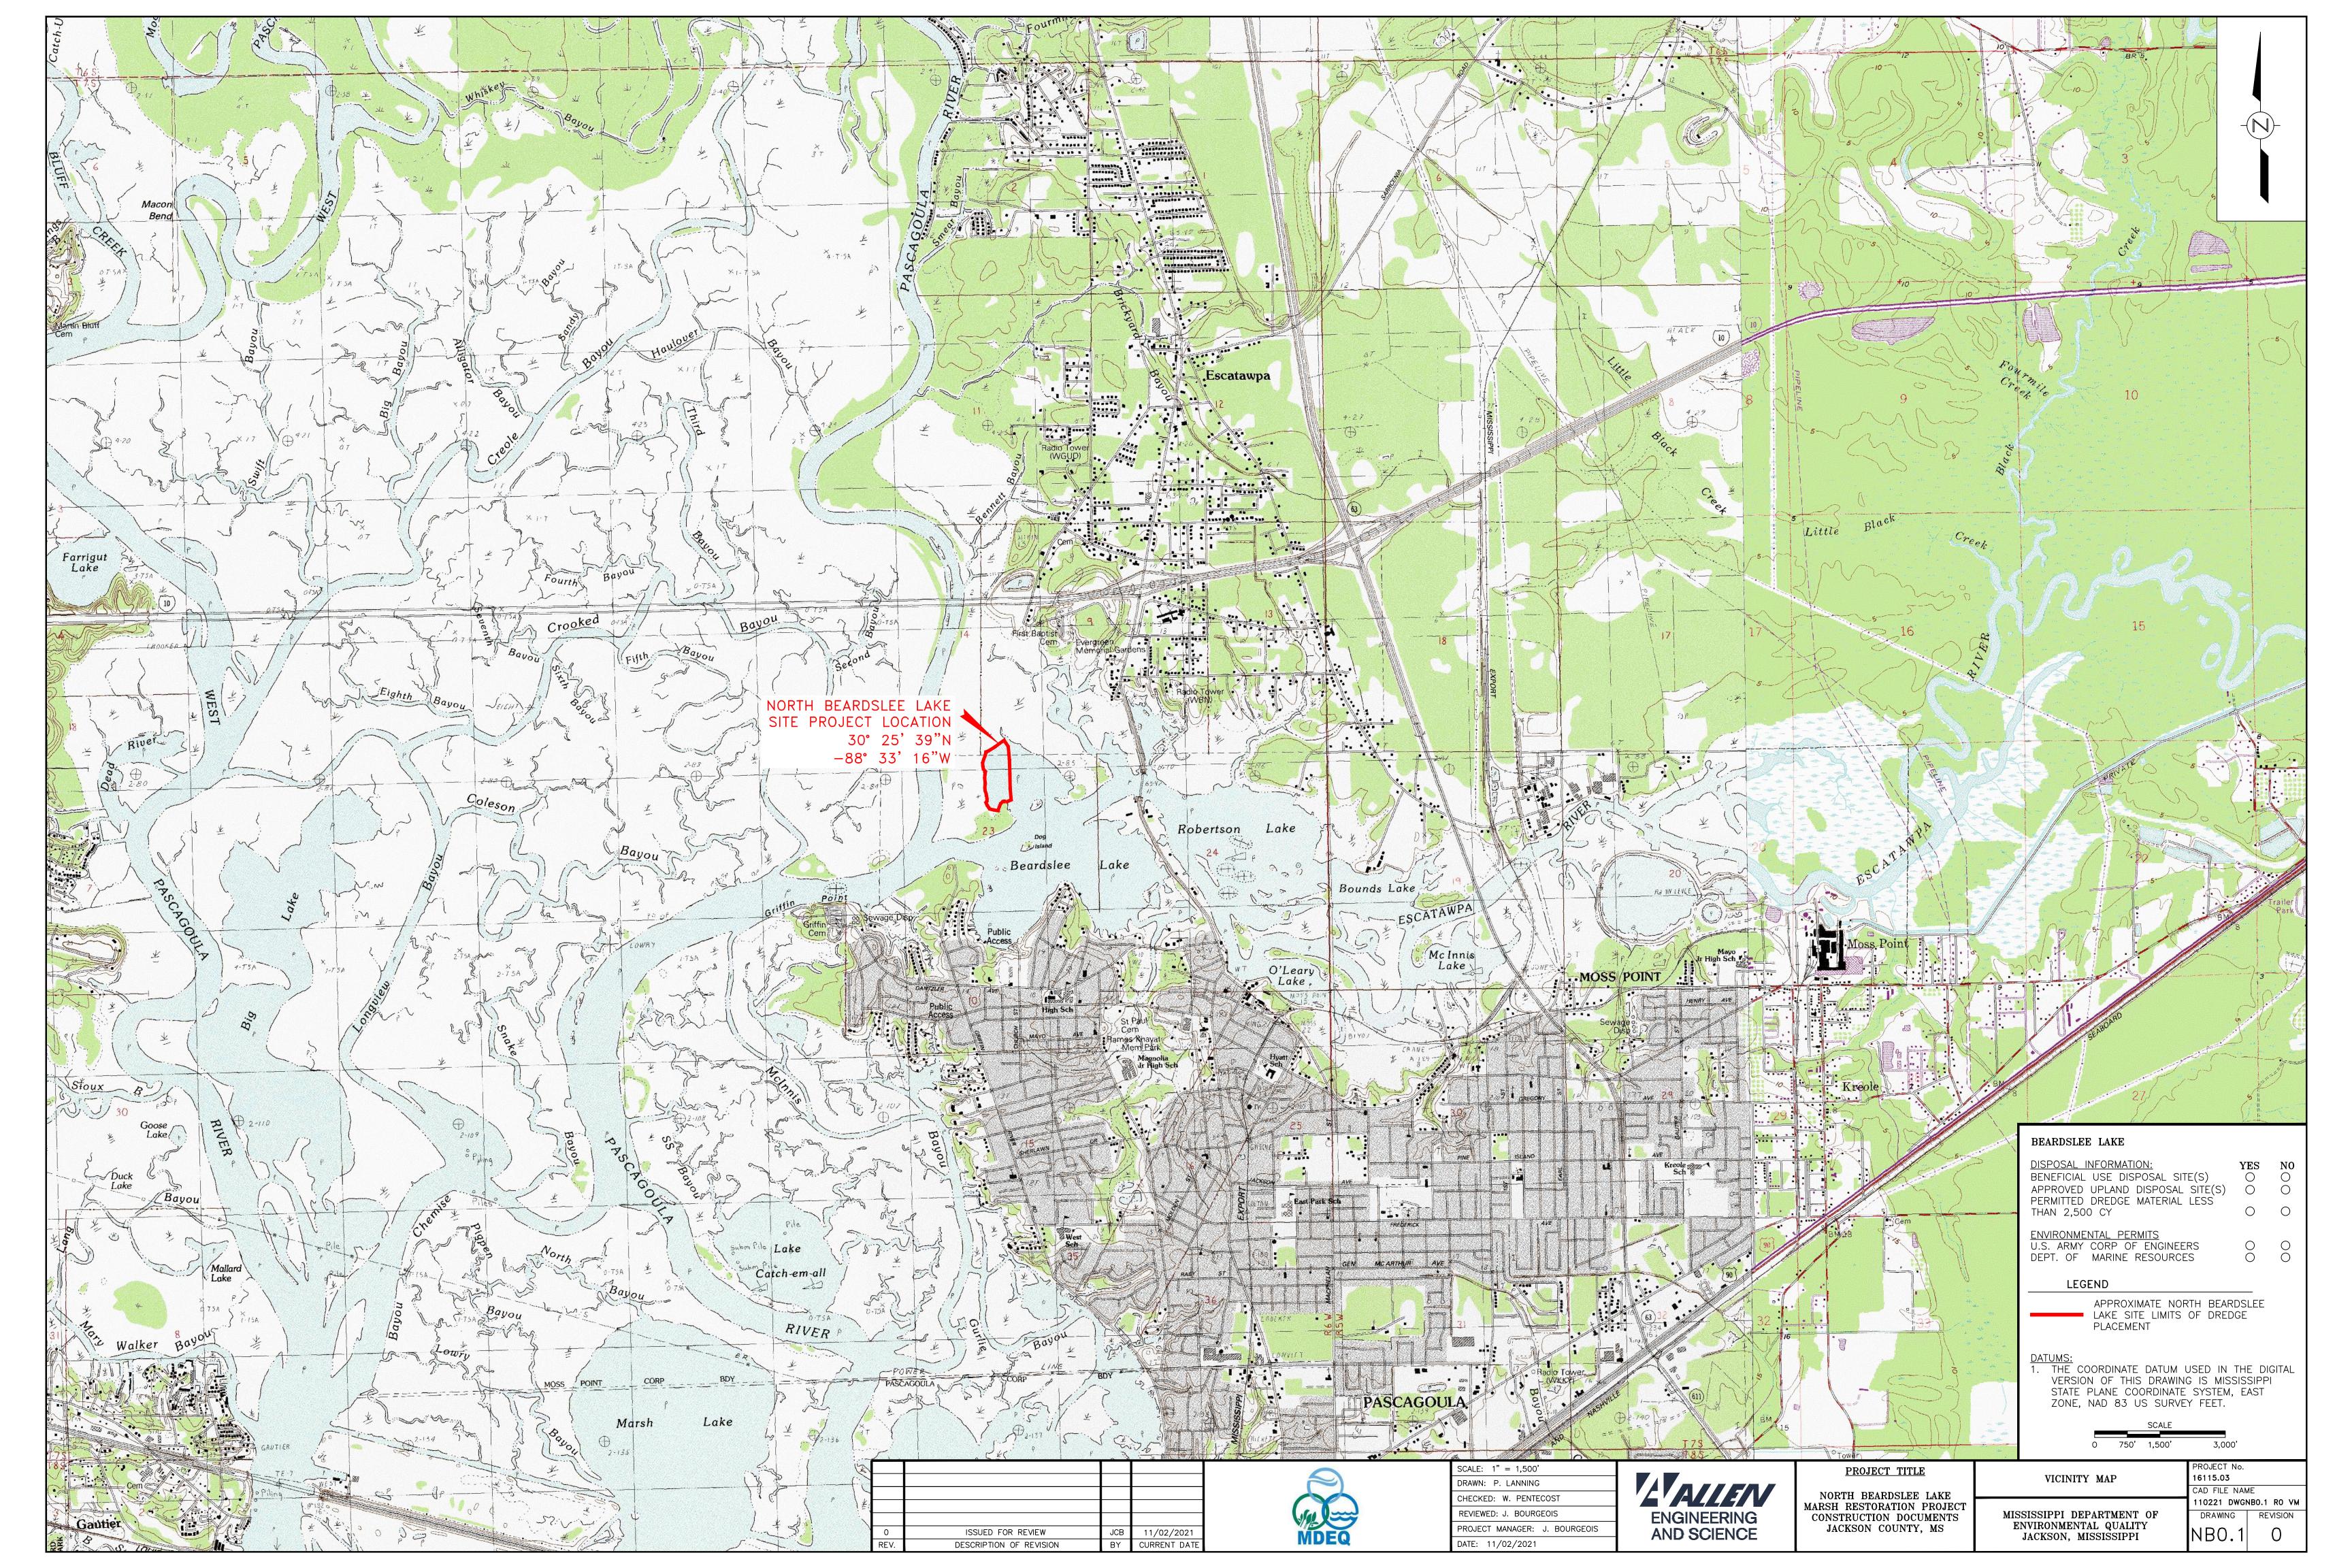

NOTE:
AFTER THE COMPLETION OF PHASE 1, THE CONTRACTOR SHOULD ANTICIPATE A SETTLEMENT PERIOD FOR THE PHASE 1 WORK OF A MINIMUM OF 120 DAYS, BUT NOT MORE THAN 180 DAYS. CONTRACT TIME WILL CONTINUE THROUGHOUT THE SETTLEMENT PERIOD.

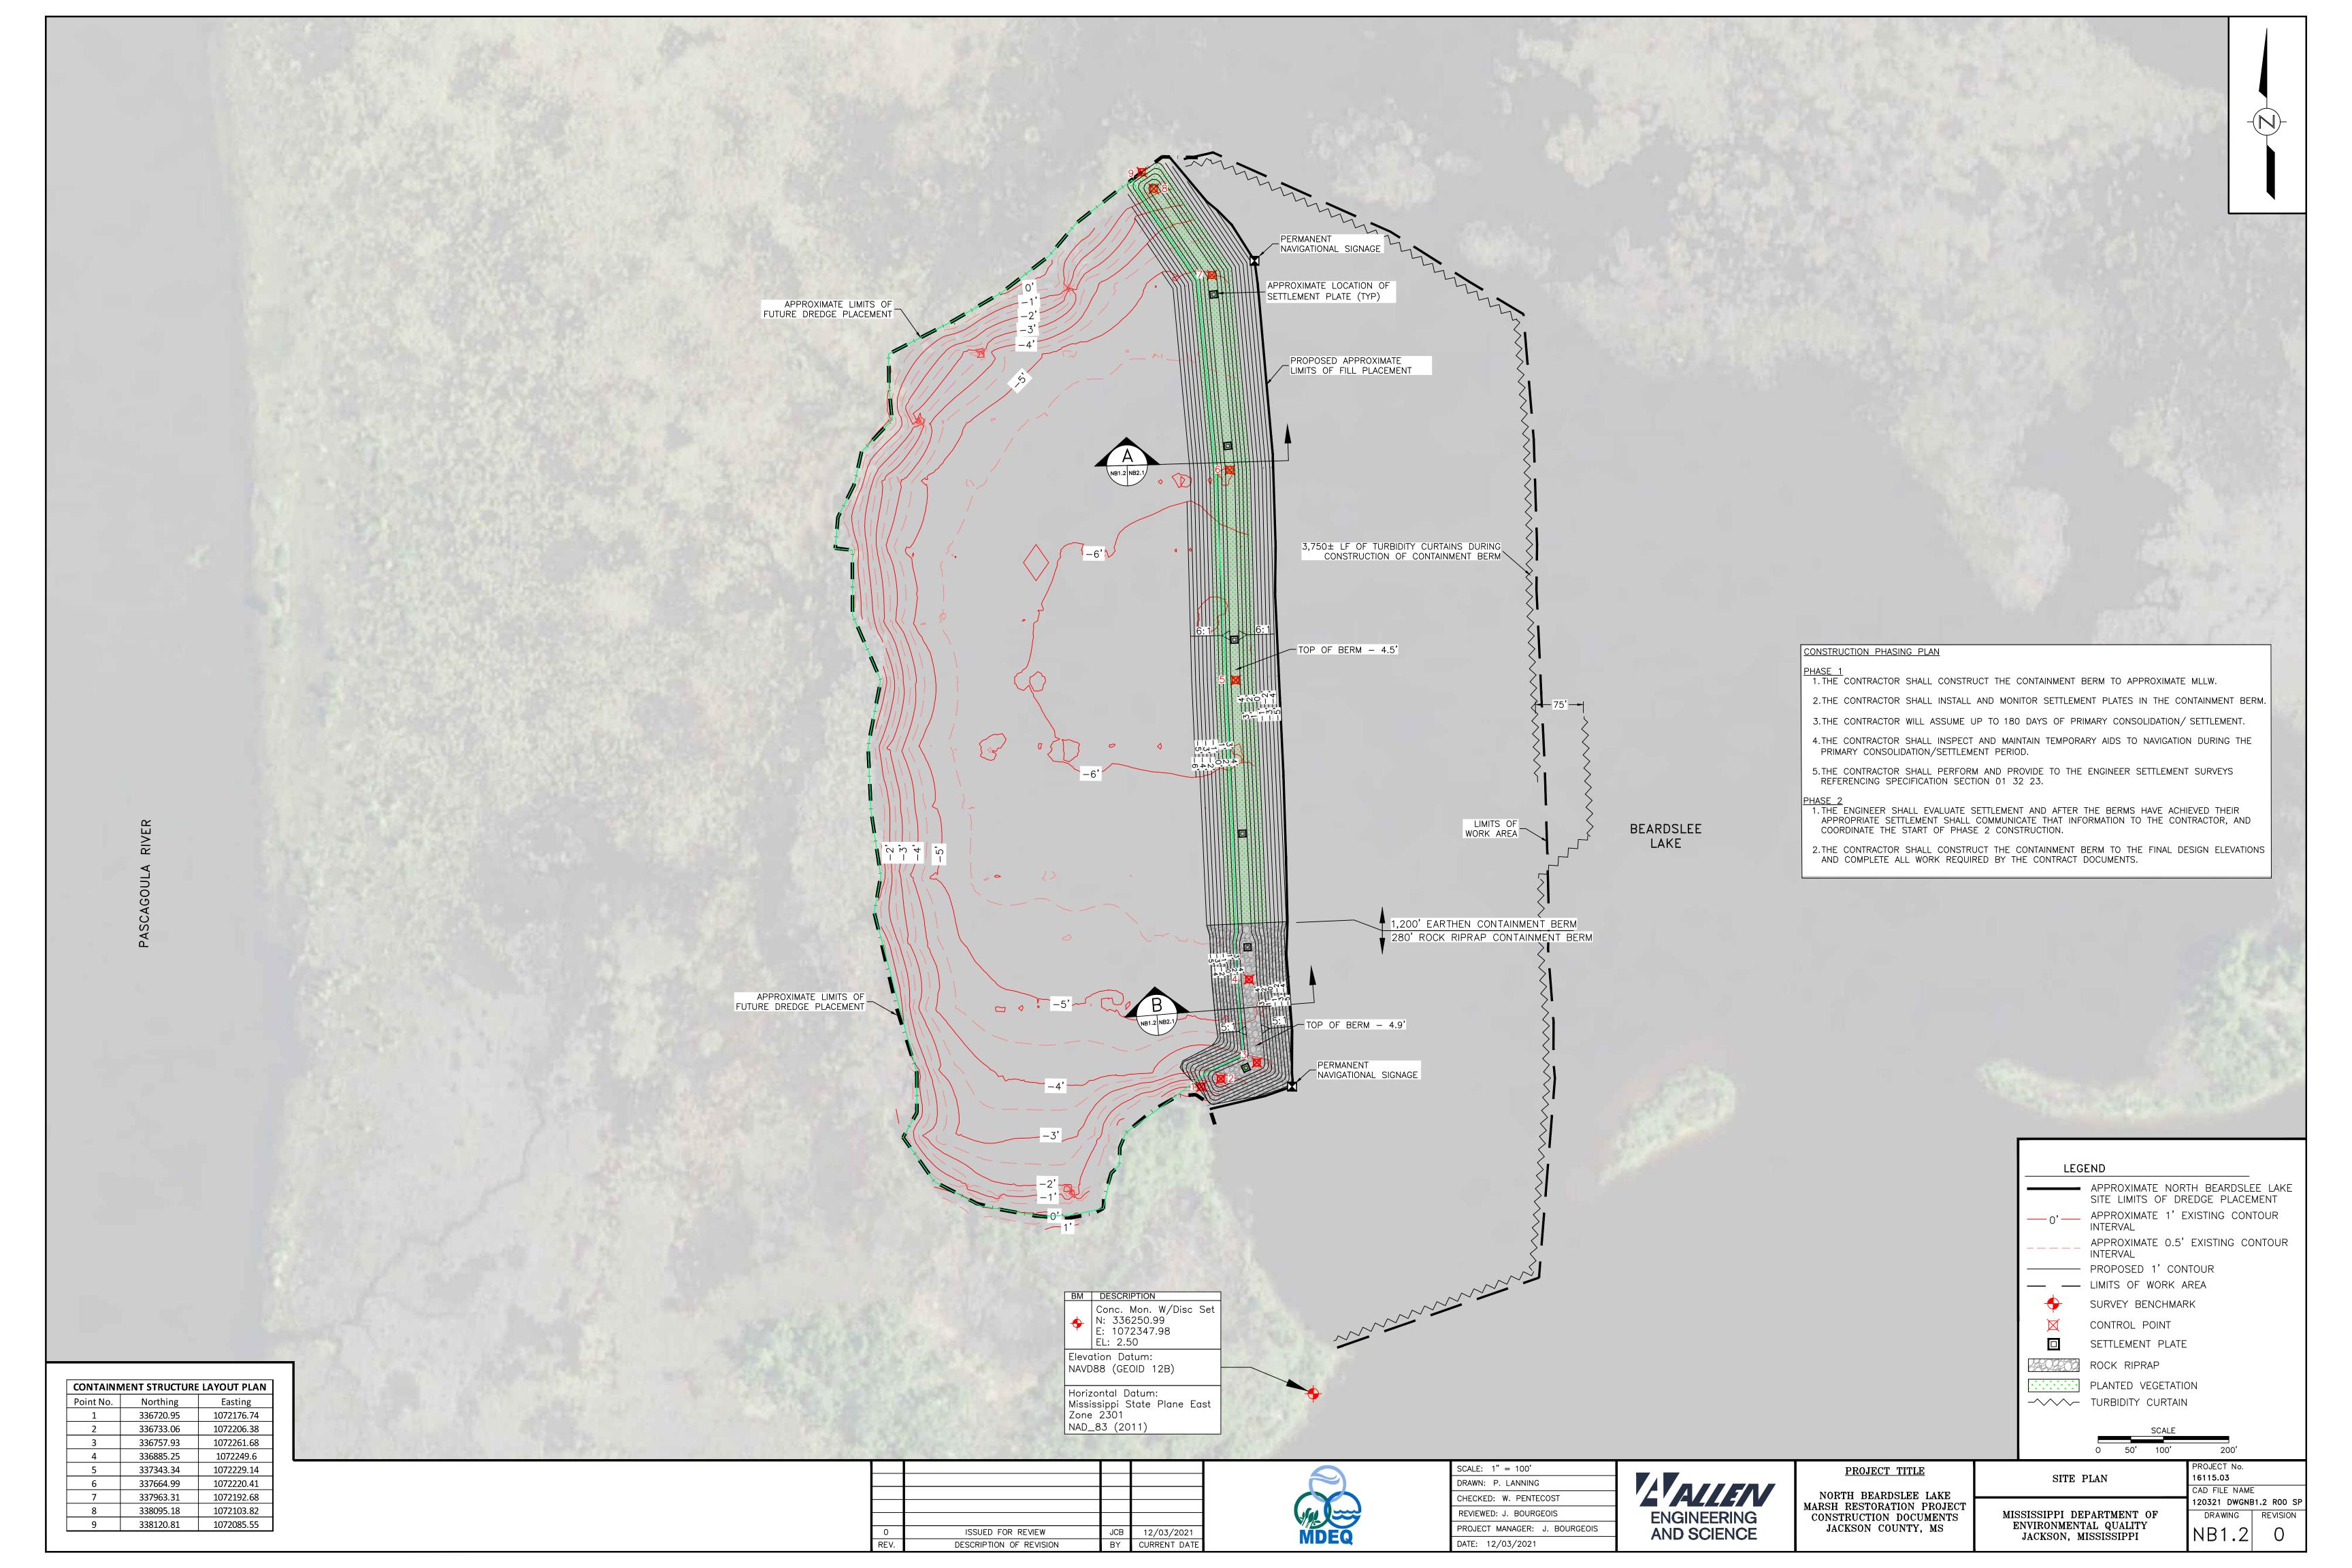
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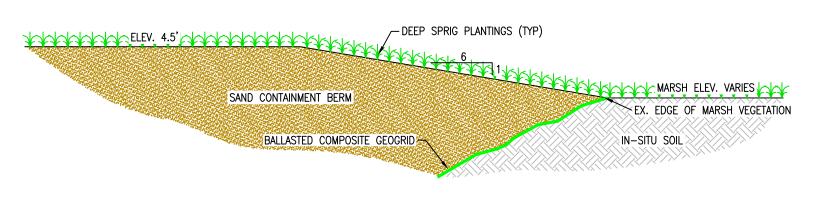
1. CONTRACTOR SHALL PLANT NEW WETLAND VEGETATION ON COMPLETED SAND BERM. PLANTINGS SHALL EXTEND DOWN SLOPES TO M.L.L.W. ELEVATION AND ACROSS THE TOP OF THE BERM. ALL COASTAL PLANTINGS SHALL BE FULL HEALTHY PLANTS. CONTRACTOR SHALL PROTECT SETTLEMENT PLATES THROUGHOUT CONSTRUCTION. 4. ALTERNATIVE #1 - CONTRACTOR SHALL INSTALL 3 LAYERS OF PRE VEGETATED EROSION

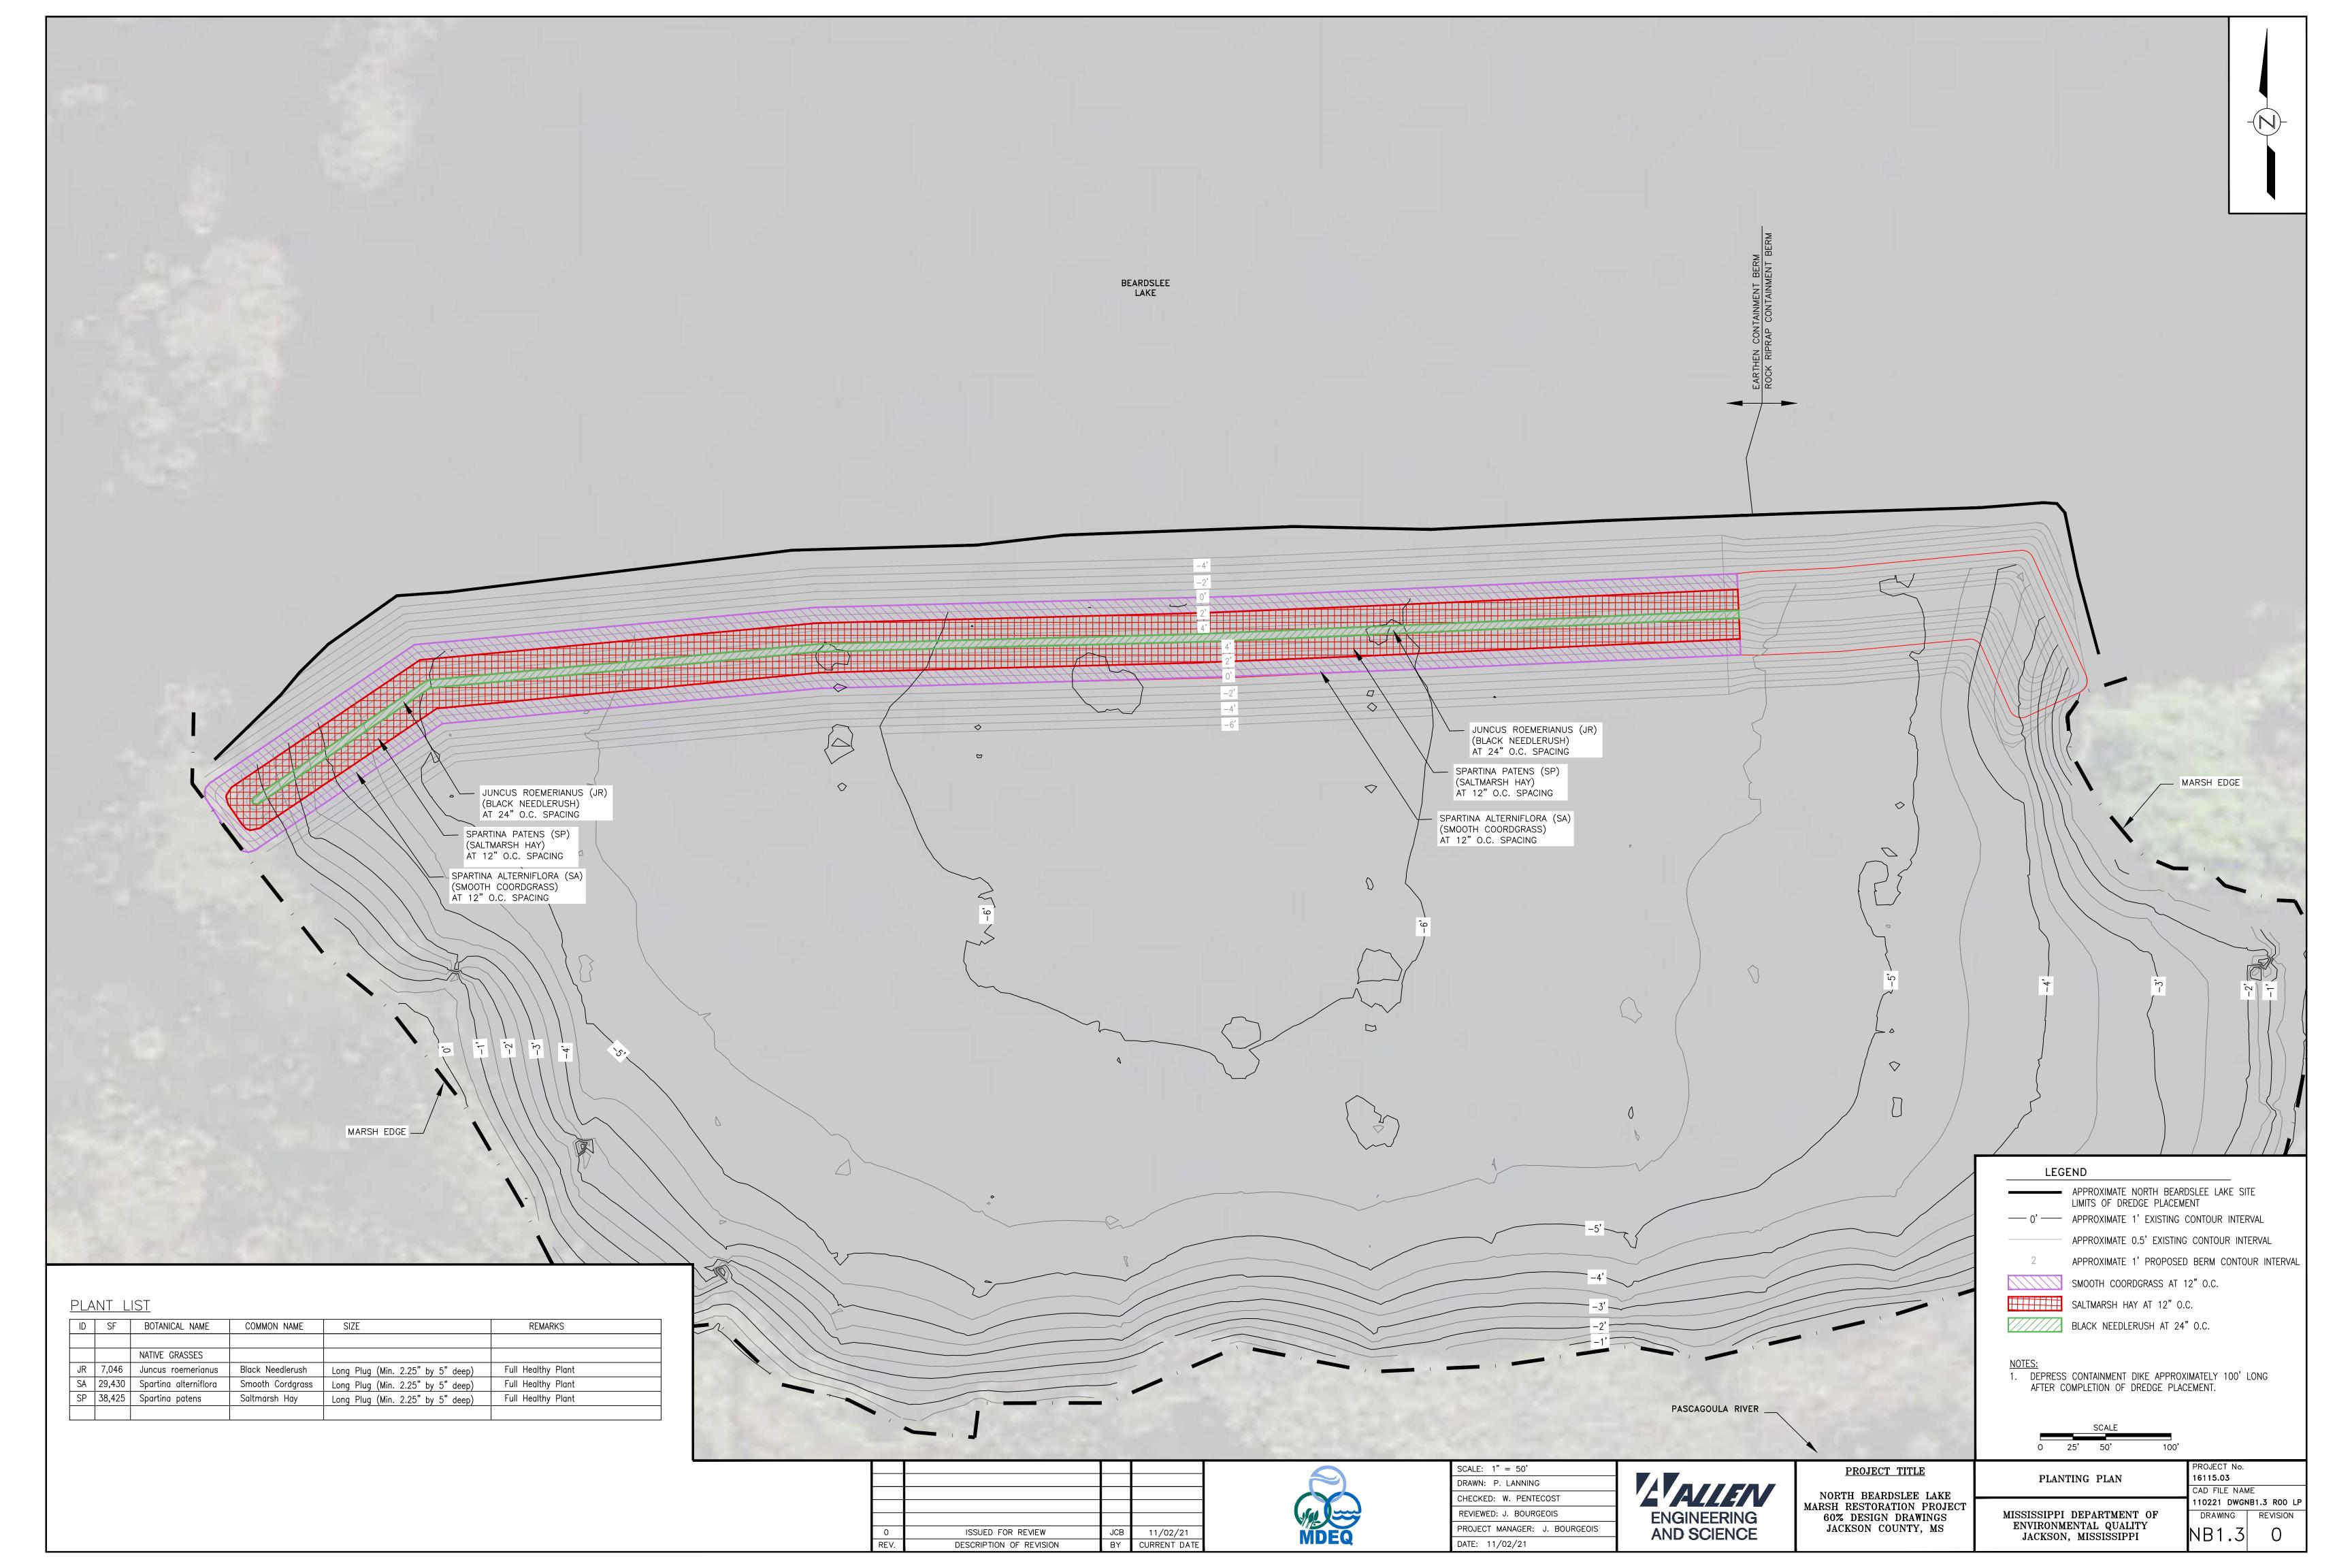CONTROL MAT, SIMILAR TO MARTIN ECOSYSTEMS - VEGETATED ECO-SHIELD OR EQUAL,


BEGINNING AT THE M.L.L.W. LINE.



ROCK RIPRAP BERM TO MARSH TRANSITION SCALE: N.T.S.

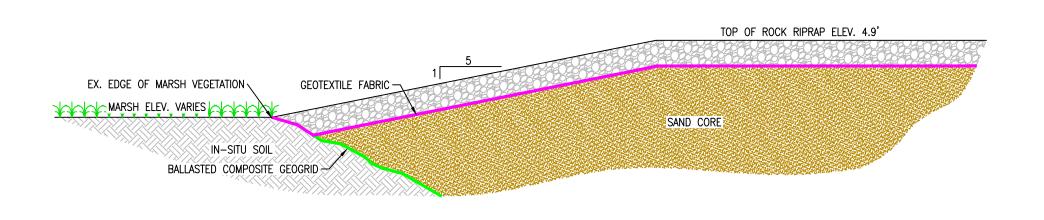


EARTHEN BERM TO MARSH TRANSITION SCALE: N.T.S.

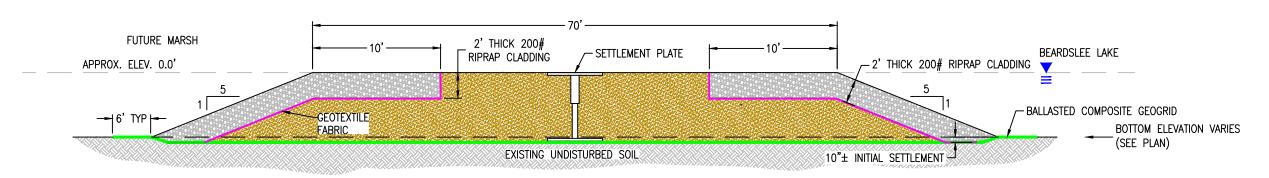


B ROCK RIPRAP CLAD CONTAINMENT BERM SECTION - PHASE 1
SCALE: N.T.S.

NOTE:
AFTER THE COMPLETION OF PHASE 1, THE CONTRACTOR SHOULD ANTICIPATE A SETTLEMENT PERIOD FOR THE PHASE 1 WORK OF A MINIMUM OF 120 DAYS, BUT NOT MORE THAN 180 DAYS. CONTRACT TIME WILL CONTINUE THROUGHOUT THE SETTLEMENT PERIOD.

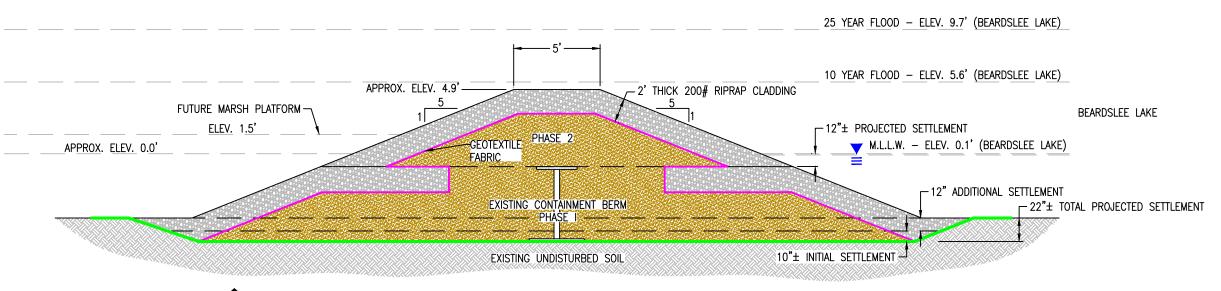

B ROCK RIPRAP CLAD CONTAINMENT BERM SECTION — PHASE 2

SCALE: N.T.S.

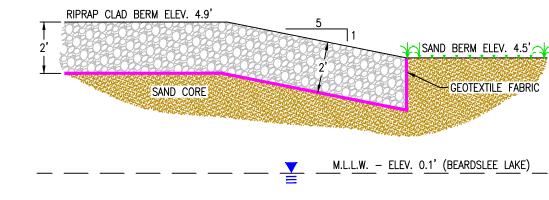

ROCK RIPRAP TO SAND BERM TRANSITION SCALE: N.T.S.

LEGE	ND
	UNDISTURBED SOIL
	SAND
	ROCK RIPRAP
	BALLASTED COMPOSITE GEOGRID
	GEOTEXTILE FABRIC
	PRE-VEGETATED EROSION CONTROL MATTING
	PROJECT No.

0	ISSUED FOR REVIEW	JCB	11/02/2021
REV.	DESCRIPTION OF REVISION	BY	CURRENT DATE



SCALE: NOT TO SCALE DRAWN: N. SISSON CHECKED: W. PENTECOST **ENGINEERING** REVIEWED: J. BOURGEOIS PROJECT MANAGER: J. BOURGEOIS AND SCIENCE DATE: 11/02/2021

PROJECT TITLE NORTH BEARDSLEE LAKE MARSH RESTORATION PROJECT CONSTRUCTION DOCUMENTS JACKSON COUNTY, MS

TYPICAL SECTIONS AND DETAILS

MISSISSIPPI DEPARTMENT OF ENVIRONMENTAL QUALITY JACKSON, MISSISSIPPI

CAD FILE NAME 110221 DWGNB2.1 RO TSAD DRAWING REVISION NB2.1

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